
LOCATION

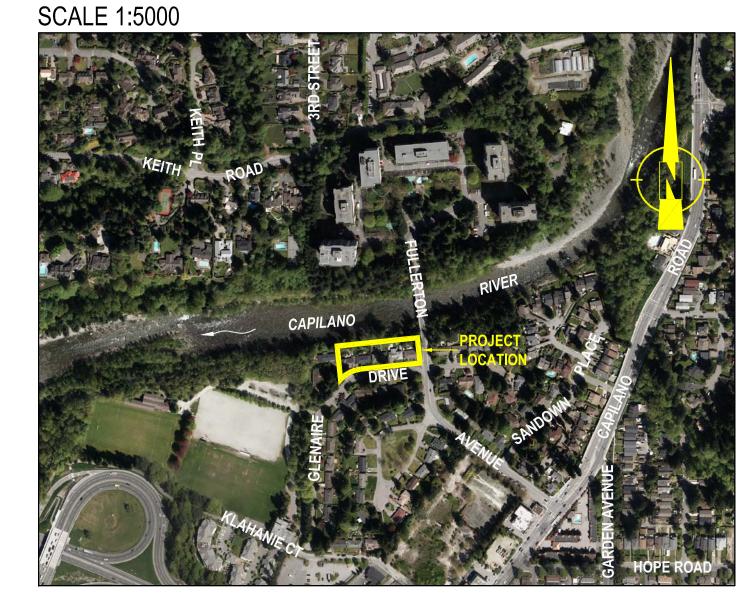


PLANT SPECIES LIST AND SPECIFICATIONS

SYMBOL	COMMON NAME	LATIN NAME	NUMBER	COMMENTS
Cd	black hawthorn	Crataegus douglasii	10	1.2m min. container grown; densely branched; well established
Am	broadleaf maple	Acer macrophyllum	11	1.2m min. container grown; densely branched; well established
Am	broadleaf maple	Acer macrophyllum	29	no. 2 pot; densely branched; well established
Pm	Douglas-fir	Pseudotsuga menziesii	7	1.2m min. container grown; densely branched; well established
Pm	Douglas-fir	Pseudotsuga menziesii	9	no. 2 pot; densely branched; well established
Ar	red alder	Alnus rubra	2	1.2m min. container grown; densely branched; well established
(Tp)	western redcedar	Thuja plicata	8	1.2m min. container grown; densely branched; well established
	western redcedar	Thuja plicata	25	no. 2 pot; densely branched; well established
©	baldhip rose	Rosa gymnocarpa	241	no. 2 pot; densely branched; well established
	beaked hazelnut	Corylus cornuta	5	no. 2 pot; densely branched; well established
©	Indian plum	Osmaronia cerasiformis	81	no. 2 pot; densely branched; well established
	oceanspray	Holodiscus discolor	34	no. 2 pot; densely branched; well established
(5)	red elderberry	Sambucus racemosa	12	no. 2 pot; densely branched; well established
(A5)	salal	Gaultheria shallon	74	no. 2 pot; multi-stemmed; densely branched; well established
<u>S</u>	snowberry	Symphoricarpos albus	413	no. 2 pot; densely branched; well established
	thimbleberry	Rubus parviflorus	123	no. 2 pot; multi-stemmed; densely branched; well established
<u>A</u>	vine maple	Acer circinatum	151	no. 2 pot; multi-stemmed; densely branched; well established
(h)	western hemlock	Tsuga heterophylla	6	no. 2 pot; multi-stemmed; densely branched; well established
0	sword fern	Polystichum munitum	150	no. 1 pot; well established
0	red huckleberry	Vaccinium parvifolium	15	no. 1 pot; well established
•	snag	Min. 15% composition of the following: Tsuga heterophylla	10	no. 1 pot; well established
	woody debris	Pseudotsuga menziesii Populus balsamifera ssp. trichocarpa Acer macrophyllum	28	3.0m - 5.0m in length; 300mm Ø min.

Existing Trees to be Retained

PLAN

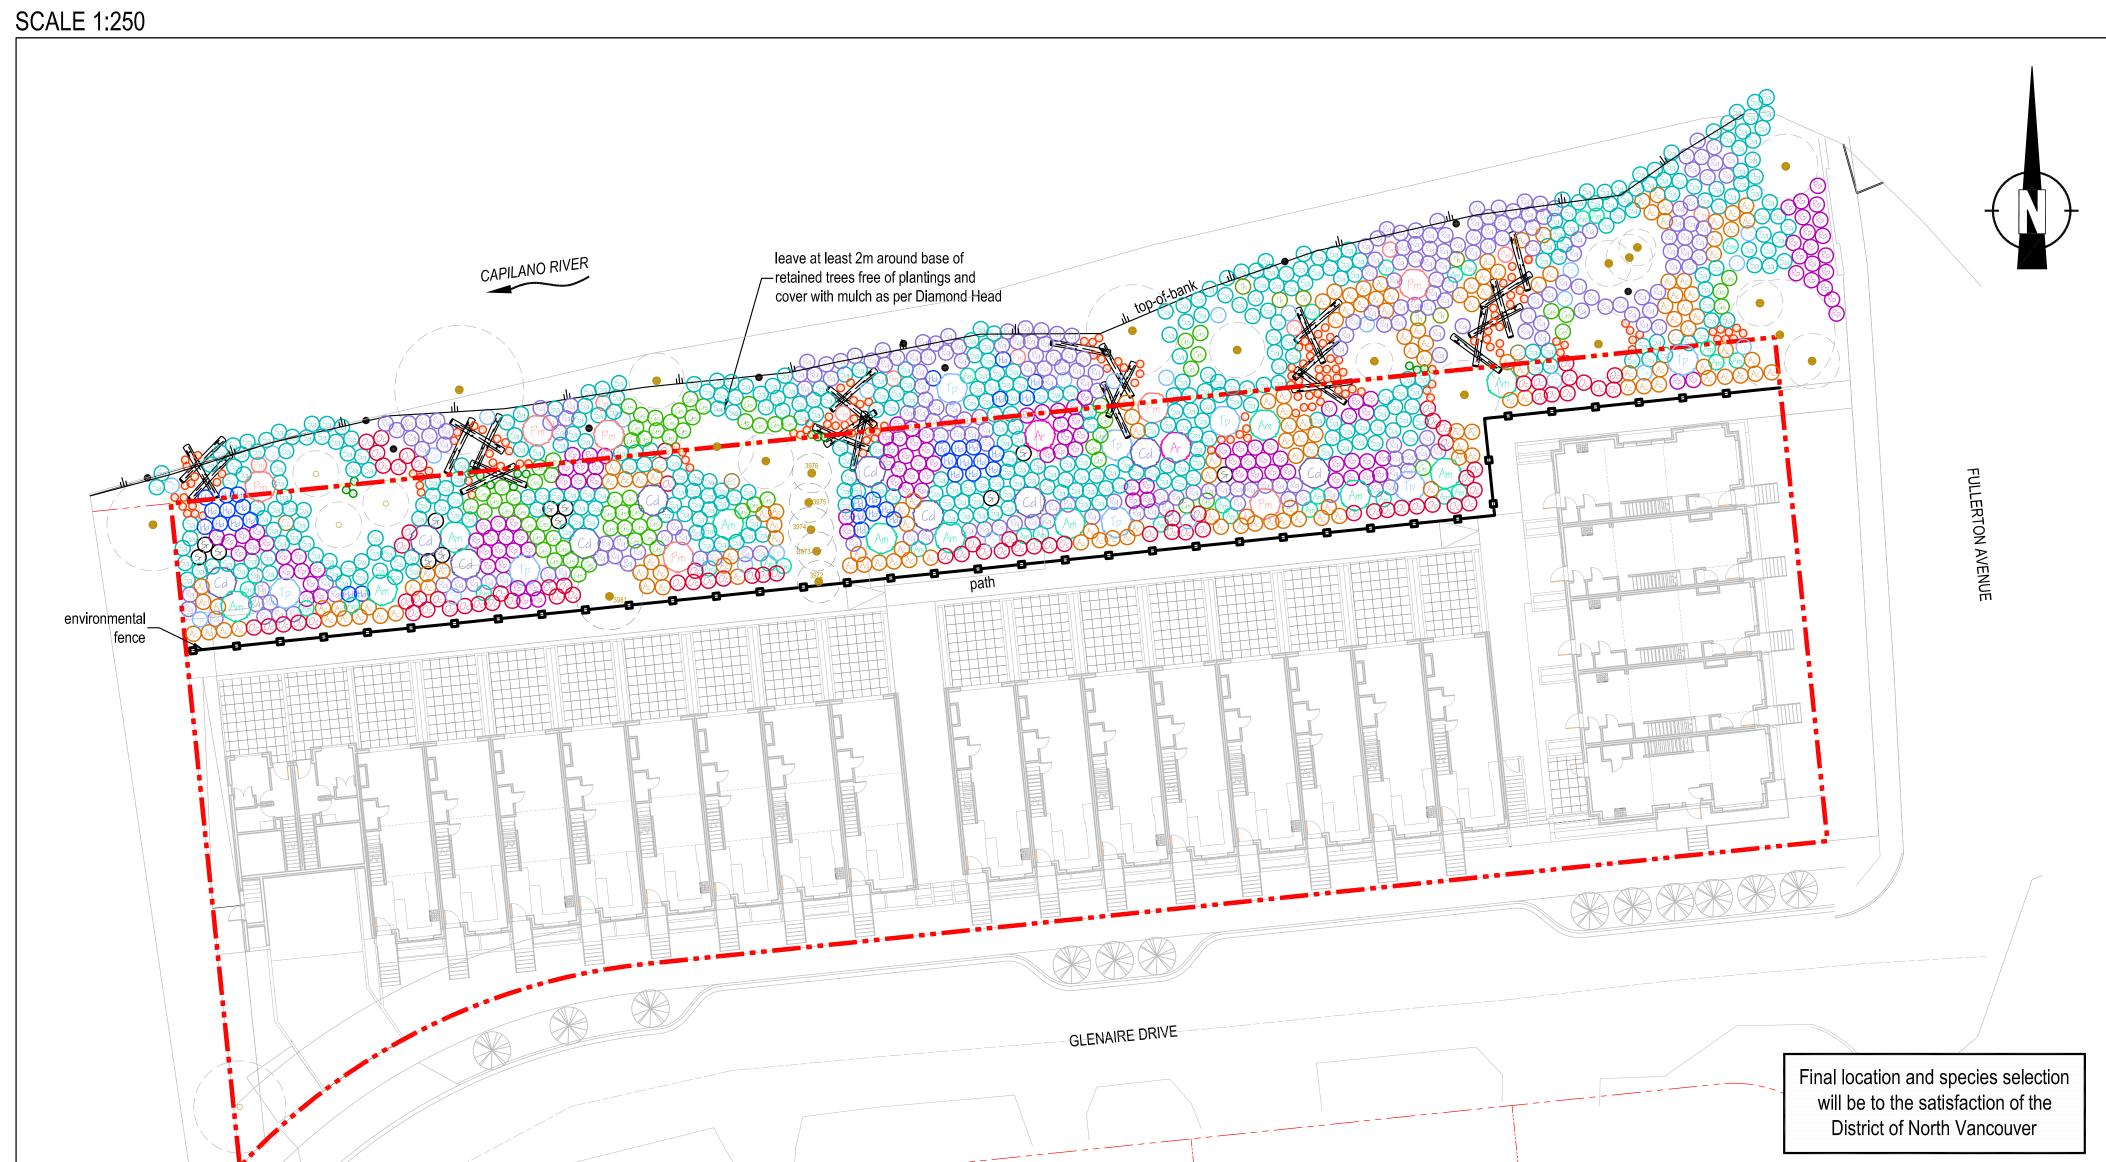


REFERENCE DRAWINGS

1. Drawing No. DP 1.5. "Site Plan Overall". March 30, 2016. Grimwood Architecture.

2. 2013 Ortho Photograph From District of North Vancouver.

PC URBAN PROPERTIES CORP.

GLENAIRE DRIVE North Vancouver, BC

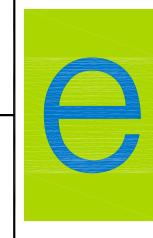

envirowest consultants inc.

Suite 101 - 1515 Broadway Street Port Coquitlam, British Columbia Canada V3C 6M2 office: 604-944-0502 facsimile: 604-944-0507

www.envirowest.ca


LANDSCAPE PLAN

DRAWN: SCM/CEV DRAWING NUMBER: As Shown 1611-04-03 SHEET 1 OF 2 June 27, 2016

TYPICAL CONTAINER (No. 7 POT) TREE PLANTING DETAIL

2 pressure treated 50mm - 75mm Ø round wood stakes (2000mm length) Tree to be Planted with Top of Pot Level with Finish Grade 1200mm Finish Grade Growing Medium of Tree Pit -Minimum


TYPICAL CONTAINER SHRUB AND No. 1 AND 2 POT TREE PLANTING DETAIL N.T.S.

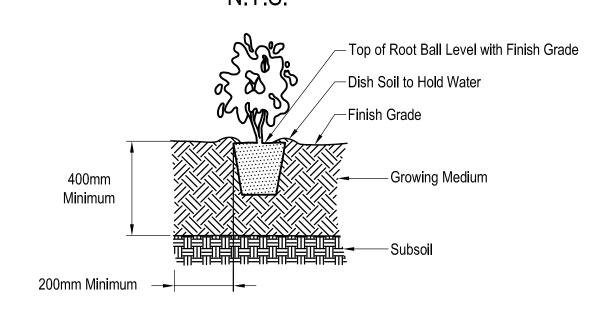


TYPICAL SNAG PLACEMENT DETAIL

N.T.S. 3 branch stubs min. 1.0m long located in the top 1/3 of the trunk 400mm Ø min. 6.0m min. length Tree species in order of preference: with 1/3 of trunk below ground -Thuja plicata, Tsuga heterophylla, and 2/3 of trunk above ground Pseudotsuga menziesii


DISTRICT OF NORTH VANCOUVER SSD-L5 ENVIRONMENTAL FENCE DETAIL

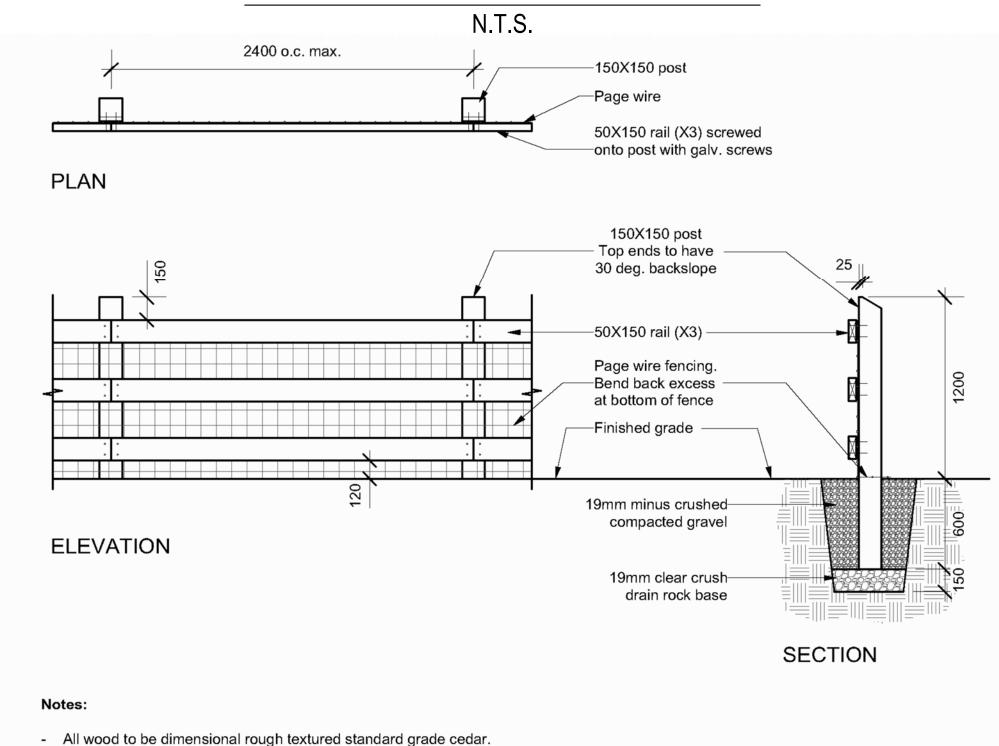

TYPICAL LOG ON LOG DETAIL

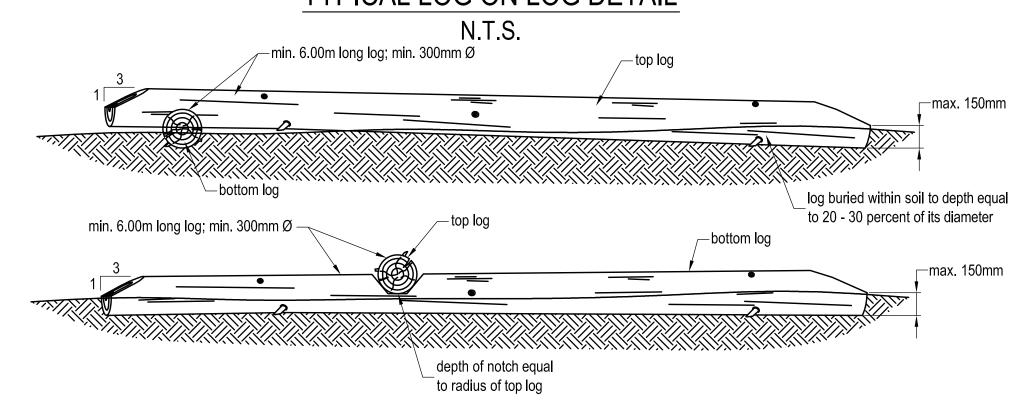

TYPICAL LOG ON GROUND DETAIL

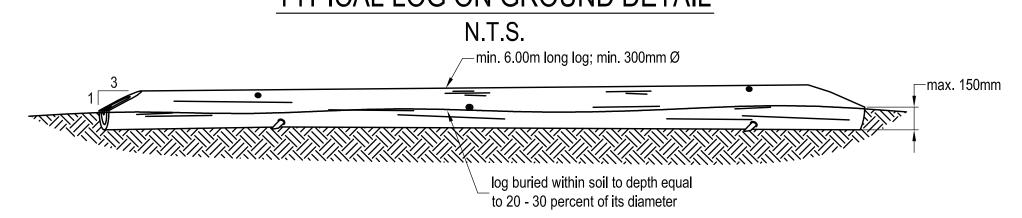

GENERAL LANDSCAPE SPECIFICATIONS

- 1. Plant material and the planting of such material are to be in accordance with the British Columbia Landscape Standard (seventh edition) jointly published by the British Columbia Society of Landscape Architects and the British Columbia Landscape Nursery Association.
- 2. All works are to be conducted in accordance with the sediment control provisions of the "Land Development Guidelines for the Protection of Aquatic Habitat" jointly published by BC Ministry of Environment and Fisheries and Oceans Canada.
- 3. All plant material is to be inspected and approved by Envirowest prior to installation.
- 4. Growing medium is to be free of any subsoils, roots, noxious grass, weeds, toxic materials, stone over 30 mm diameter, foreign objects, and possess an acidity range (pH) of 5.5 to 7.5. Growing medium is to be inspected by Envirowest prior to placement. All blackberry (Rubus discolor and R. laciniatus) to be cleared and grubbed from project site.
- 6. All debris and/or excess material from landscape operations are to be collected and disposed offsite in accordance with all
- 7. Disturbed areas to be seeded with red fescue (Festuca rubra) augmented with fireweed (Epilobium angustifolium) and
- goldenrod (Solidago canadensis) seed; percentage composition and application rate of final seed mix to be determined by 8. All western redcedar (*Thuja plicata*) must be of native stock; any cultivars, such as *T. plicata* var. excelsa, are not to be planted.
- 9. The contractor is to provide two (2) years of plant maintenance. Plant maintenance is to include watering, selective pruning and clearing of blackberry. Species survivorship is to equal one-hundred (100) percent two (2) years from planting. Replacement of dead stock may be required to fulfill this specification. Replacement stock is also subject to one-hundred (100) percent survivorship two (2) years from planting.
- 10. All existing structures and hard landscaping must be removed from streamside protection area prior to planting.
- 11. Each plant to be tagged with the botanical name and log to be left attached after planting.

PC URBAN PROPERTIES CORP.

- Page wire to be Low Carbon Field Fence, product # 118233, by Bekaert. Supplied by Otter Co-op (604-607-6909),

- All wood to be stained with BRODA PRO-TEK-TOR Deck-Rail Water-borne Natural Oil finish

- Contractor to provide sample of materials for DNV Representative's approval prior to installation.

- Confirm layout on site with DNV Representative prior to installation.

or Fraser Valley Steel (604-856-3391, or approved equal.

- Restore any disturbed areas to the satisfaction of the DNV Representative.

- Ensure all page wire is taut and aligned at right angles with posts and rails.

- All fence posts to be installed plumb and true.

Colour to be 011A Natural Clear Lite, as supplied by CBR Products (604-254-3325), or approved equal.

GLENAIRE DRIVE North Vancouver, BC



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www.envirowest.ca

LANDSCAPE DETAILS AND SPECIFICATIONS

DESIGN:	DRAWN:	CHECKED:	REVISION:	REVISION DATE:
CG	SCM/CEV		00	
SCALE: As Shown			DRAWING NUMBER:	
DATE:	June 27, 2016		1611-04-04 SHEET 2 OF 2	